

NOIL

STORMWAT

ERS

ENERGY

FIRE

HYDRAULIC

ELECTRICAL

MECHANICAL

About Marline Engineering Newcastle At Marline, we take a comprehensive approach when designing your new development.

With in-house electrical, mechanical and hydraulic engineers, Marline Engineering makes your engineering design needs a breeze. We are able to adjust, implement and create designs on AutoCAD and REVIT which makes it easy for contractors and builders to build our designs.

We advise you on the most affordable, practical and effective solutions and systems based on the site and legal factors.

As consulting engineers, Marline has also expanded the range of services to provide a wide range of building services disciplines including Air-conditioning, Electrical, Hydraulics, Fire Protection and Lift Services.

Marline has seen a huge amount of growth in the Energy sector. We provide services that go above and beyond the standard regulatory requirements and offer unique solutions to your Section J or JV3

Alternative solution reports. We also offer a fast NABERS and BEEC certification that ensures advertising for commercial properties are fully compliant with the CBD advertising rules and regulations.

With engineering consulting experience that dates back as far as 1975, we're one of the best engineering companies in Australia, and have developed the kind of projects that residential and commercial property developers benefit from.

Our Newcastle engineering firm continues to grow, however our team prides itself on every customer receiving the kind of high quality workmanship and personalised service that our company is known for.

To accommodate the expansion and demand for engineering services within Newcastle and throughout New South Wales, Marline Engineering has almost doubled the number of highly trained employees in the last five years.

Our engineering firm currently employs ten engineers, eight technical assistants and an office administrator. As a result, we continue to be leaders amongst engineering companies in Australia, with a large portfolio and a positive attitude.

PROJECT No: MN15171

CLIENT: CABONNE COUNCIL

ARCHITECT:

Hydraulic Services

CABONNE HOME SUPPORT

REFURBISHMENT
70 GASKILL STREET CANOWINDRA, NSW 2804

DRAWING SCHEDULE

HY-00-000 HY-00-001 HY-00-002	COVER SHEET LEGEND & NOTES SITE SERVICES
HY-10-001	GROUND FLOOR - WATER & GAS LAYOUT
HY-20-001 HY-20-002	GROUND FLOOR - SANITARY DRAINAGE LAYOUT ROOF - DRAINAGE LAYOUT
HY-30-001	DETAILS

100% ISSUE

LINETYPES - EXISTING

———— eCW — COLD WATER —— - — eHW —— HOT WATER ------ eWW ------ WARM WATER ----- eSP ----- FIRE SPRINKLER — - - — eG — GAS —————————————NON POTABLE

es SANITARY — — — — eVP — VENT PIPE OFFSET ------ eTW ------- TRADE WASTE

————— eDP —— STORMWATER TO RWT eOF STORMWATER OVERFLOW

------ ess ------ SUBSOIL DRAIN

////// DISUSE PIPE

----- eSW ----- STORMWATER

LINETYPES - NEW

---- COLD WATER — – HOT WATER HOT WATER FLOW WARM WATER TEMPERED WATER — · · — · · — FIRE HYDRANT - SP - FIRE SPRINKLER NON POTABLE RAINWATER REUSE SANITARY

── TW ───── TRADE WASTE PD PD PUMP DISCHARGE → DP ← STORMWATER TO RWT

---- VENT PIPE OFFSET

BALCONY DRAIN TO STORMWATER RECYCLED/RECLAIMED WATER STORMWATER OVERFLOW — ss — SUBSOIL DRAIN

SYMBOLS - OTHER

PIPEWORK CAP **EXPANSION LOOP** PIPEWORK PENETRATION TEE

0 PIPEWORK PENETRATION RISER PIPEWORK PENETRATION DROPPER

PIPEWORK DROP DOWN

xxx FU FIXTURE UNITS xxx LU LOADING UNITS MEGA JOULES xxx MJ xxx L/s LITRES/SECOND

FLOW ARROW PIPEWORK RISES

PIPEWORK DROPS

PIPEWORK RISES & DROPS SURFACE LEVEL \times 0.00

PIPEWORK REDUCER

SYMBOLS - WATER

ISOLATION VALVE BALANCING VALVE CHECK VALVE

REFLUX VALVE IN SHAFT WITH INSPECTION OPENING

 \bowtie WATER VALVE IN PATH BOX CIRCULATING PUMP

DUAL CHECK VALVES \bowtie

REDUCES PRESSURE ZONE DEVICE \bowtie + ∞ + ∞ + ∞ THERMOSTATIC MIXING VALVE T

TMV THERMOSTATIC MIXING VALVE IN WALL BOX

TEMPERING VALVE

TV TEMPERING VALVE IN WALL BOX

MAIN WATER METER PRIVATE WATER METER

HOT WATER STORAGE UNIT

MICRON FILTER

SYMBOLS - FIRE

 $\langle T \rangle$

BOOSTER ASSEMBLY PUMP SET VALVE SET **TEST POINT ALARM STROBE** \emptyset SINGLE PILLAR HYDRANT (INTERNAL) DOUBLE PILLAR HYDRANT (EXTERNAL) STREET HYDRANT FIRE HOSE REEL THRUST BLOCK FIRE INDICATOR PANEL

SYMBOLS - STORMWATER

GRATED DRAIN **GRATED PIT** SEALED PIT

SYMBOLS - SANITARY

AIR ADMITTANCE VALVE FLOOR WASTE BASKET FLOOR WASTE CHROME PLATED BRASS SCREWED CAP SEALED FLOOR WASTE OVERFLOW GULLY CLEAR OUT/INSPECTION OPENING SANITARY FIXTURE INSPECTION SHAFT

DOWNPIPE WITH SPREADER

INSPECTION SHAFT WITH BOUNDARY TRAP oд INDUCT PIPE MICA FLAP TUNDISH ON WALL ___ TUNDISH INWALL SEWER ACCESS CHAMBER SEWER MAINTENANCE SHAFT PLASTER TRAP SWIVEL EXPANSION JOINT PIPEWORK CAST IN BEAM

BUNDED AREA

ABBREVIATIONS

ART TROUGH. AIR CONDITIONING UNIT. ACU AIR ADMITTANCE VALVE AAVBUCKET FLOOR WASTE. BUCKET SINK. BAR SINK. BIDETTE. BID BOUNDARY TRAP. **BOILING WATER UNIT** BWU CONDENSATE DRAIN. CD CO CLEAROUT. CPC CHROME PLATED BRASS SCREWED CLEAROUT. CLEANERS SINK. DCV DOUBLE CHECK VALVE (TESTABLE). DIESEL EXHAUST. DRINKING FOUNTAIN. DN DIAMETER NOMINAL

DISCONNECTOR GULLY. DG DOWNPIPE. DPH DOUBLE PILLAR HYDRANT. DRINKING TROUGH. DUCV DUAL CHECK VALVE DW DISHWASHER. EXISTING. ELEVATED DRAINAGE. EXISTING SEWER ACCESS CHAMBER. EXISTING STORMWATER PIT.

EYE WASH. EW **FUME CUPBOARD** FIRE HYDRANT. FLOOR LEVEL FLUSHER SANITIZER FSL FINISHED SURFACE LEVEL. FIXTURE UNITS.

FW FLOOR WASTE. GAS BAYONET. GB GCH GAS CONVECTION HEATER GCT GAS COOK TOP. GRATED DRAIN. GD GW **GLASS WASHER** HANDBASIN.

HOSE TAP. **HWC** HUNTER WATER CORPORATION. HWU HOT WATER UNIT. INVERT LEVEL.

ICE MACHINE. INSPECTION OPENING. INSPECTION SHAFT. INDUCT PIPE MICA FLAP. KERB INLET PIT. LPG LIQUID PETROLEUM GAS. LABORATORY SINK.

NATURAL GAS. OVERFLOW GULLY. PLASTER ARRESTOR PAT PRACTICAL ACTIVITIES TROUGH. PLANTER DRAIN. RELATIVE LEVEL

REDUCED PRESSURE ZONE DEVICE. RWO RAIN WATER OUTLET. REFLUX VALVE. SAC SEWER ACCESS CHAMBER

SHOWER. SLOP HOPPER. SEALED FLOOR WASTE SURFACE LEVEL SEWER MAINTENANCE SHAFT Snk KITCHEN SINK.

SPH SINGLE PILLAR HYDRANT RAINWATER SPREADER. RAINWATER SPREADER. SAFETY SHOWER. SOIL STACK. STERILIZER. SPRINKLER VALVE SET. SVS

TUBS. TUNDISH. THERMOSTATIC MIXING VALVE. TRADE WASTE VENT. UR URINAL.

VANITY BASIN VENT PIPE. WATER CLOSET. WINDOW DRENCHER WASHING MACHINE. WASTE STACK. WS WASH TROUGH.

GENERAL NOTES

1. IT IS THE CONTRACTORS RESPONSIBILITY TO OBTAIN A 'DIAL BEFORE YOU DIG' TO ASCERTAIN THE FULL EXTENT OF EXISTING SERVICES SURROUNDING THE SUBJECT PROPERTY. PRIOR TO ANY EXCAVATION THE RELEVANT AUTHORITIES eg TELSTRA OPTUS, AGILITY etc. ARE TO BE NOTIFIED OF ALL WORKS.

2. ALLOW TO PAY ALL FEES & CHARGES FOR ALL AUTHORITIES RELATING TO ALL WORKS DESIGNED & SPECIFIED.

3. IT IS THE HYDRAULIC CONTRACTORS RESPONSIBILITY TO ENGAGE A SUITABLE QUALIFIED CONTRACTOR TO CARRY OUT A THOROUGH GROUND SEARCH FOR EXISTING SERVICES AROUND AND IN THE PROPOSED BUILDING FOOTPRINT. NOTIFY THE SUPERINTENDENT IMMEDIATELY IF ADDITIONAL SERVICES TO THAT DOCUMENTED ARE LOCATED. THIS IS TO BE CARRIED OUT PRIOR TO ANY WORKS BEING COMMENCED.

4. ALL HOT, WARM & COLD WATER ISOLATION VALVES SHOWN ARE TO BE LOCATED IN THE CEILING VOID COMPLETE WITH ACCESS PANEL OTHERWISE 300mm DOWN FROM CEILING IN ROOM USING ENWARE VP356 ISOLATION VALVE WITH CHROME COVERPLATE.

5. ALL EXPOSED PIPEWORK TO BE CHROME PLATED OR PAINTED AS PER SPECIFICATION.

6. ALLOW TO PREPARE & SUPPLY DETAILED "AS INSTALLED" DRAWINGS & MAINTENANCE MANUALS FOR ALL ASSOCIATED WORKS AS DETAILED IN THE SPECIFICATION.

7. SUPPLY & INSTALL FIRE STOP COLLARS etc. TO COMPLY WITH AS4072.1 TO MAINTAIN THE FIRE RATING INTEGRITY OF THE BUILDING ELEMENT BEING PENETRATED. THE COLLARS MUST COMPLY WITH ALL CLAUSES / PARTS OF AS4072.

8. CONTRACTOR TO ENSURE THAT HYDRAULIC SERVICE PENETRATIONS THROUGH FIRE RATED WALLS/CEILINGS & OTHER FIRE RATED ELEMENTS ARE PROTECTED AND MEET THE REQUIREMENTS OF SPECIFICATION 13 OF THE NCC 2022

9. ALL HYDRAULIC SERVICES PIPEWORK, EQUIPMENT & VALVES SHOULD BE LABELED TO ENABLE THEM TO BE CLEARLY IDENTIFIED. LOCATIONS OF LABELS TO BE APPROVED BY ARCHITECT.

10. ALL HOT/WARM WATER PIPEWORK TO BE INSULATED WITH THERMOTEC INSULATION OR EQUIVALENT WITH R-VALVE = 0.6 IN ACCORDANCE WITH AS/NZS 3500.4. REFER TO SPECIFICATION FOR EXACT REQUIREMENTS.

11. ALL DISRUPTIONS TO EXISTING SERVICES FOR NEW CONNECTIONS ARE TO BE COORDINATED ON SITE WITH THE PROJECT SUPERINTENDENT.

12. ALL INWALL TUNDISH ARE TO BE MODTEC OR EQUIVALENT. REFER TO DETAILS.

13. ALL EXTERNAL HOSE TAPS TO BE ENWARE KEY OPERATED HOSE TAPS FITTED WITH VACUUM BREAKERS.

14. ALL LEVELS & LOCATIONS SHOWN ON DRAWINGS FOR EXISTING PITS, SERVICES, SEWER ACCESS CHAMBERS & KERB INLET PITS ARE TO BE CONFIRMED ON SITE PRIOR TO ANY WORKS BEING CARRIED OUT.

15. ALL SERVICES INSTALLED ADJACENT THE BUILDING ARE TO BE LOCATED OUTSIDE THE ZONE OF INFLUENCE AS PER AS3500.

16. ALL LOCATIONS OF WATER POINTS FOR INTERNAL FITOUT SHOWN ON THESE PLANS ARE FOR CLARITY ONLY. FINAL LOCATIONS ARE TO BE DETERMINED USING ARCHITECTURAL 1:50 INTERNAL LAYOUTS & ELEVATIONS.

17. EXCAVATE, LOCATE & CONNECT TO EXISTING SEWER JUNCTION SERVING THE SITE.

18. SANITARY DRAINAGE OVERFLOW GULLIES TO BE PROVIDED IN ACCORDANCE WITH AS3500.2 REQUIREMENTS. IF HEIGHTS IN ACCORDANCE WITH AS3500.2,4.6.6.6 CANNOT BE ACHIEVED REFLUX VALVES MUST BE INSTALLED

19. WHERE PIPEWORK IS LIKELY TO BE EXPOSED TO FIRE IN AN AREA WITHIN A BUILDING THAT IS NOT PROTECTED BY SPRINKLERS, PIPE-SUPPORTS SHALL BE INSTALLED WITH A MINIMUM FRL NOT LESS THAN 60/-/-. THE PIPE-SUPPORTS ARE REQUIRED TO HAVE A TEMPERATURE RESISTANCE OF NOT LESS THAN 500°C WHEN TESTED IN ACCORDANCE WITH AS1530.4.

WATER PRESSURE - CENTRAL TABLELANDS WATER

HYDRANT FLOW RATE (controlled) L/S	HYDRANT PRESSURE (corresponding to the controlled flow) kPa
0	330
5	310
10	300
11.5	280
15	250
18.2	230

FIRE HYDRANT SERVICE DESIGN (STREET HYDRANT)

FIRE HYDRANT COVERAGE IS ACHIEVED COMPLETELY VIA AUTHORITY STREET FEED HYDRANTS.

BUILDING CLASSIFICATION	5/9b
RISE IN STOREY	<2
FIRE COMPARTMENT FLOOR AREA	426m2
PRESSURE REQUIRED	150kPa
WATER REQUIRED	10L/s
MINIMUM PRESSURE IN MAIN	300kPa

–MECHANICAL ——ELECTRICAL ——HYDRAULIC ——FIRE ——ENERGY ——NABERS ——STORMWATER ——SECTION J ——BEEC —



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3 21.11.24 100% ISSUE 2 21.10.24 75% ISSUE FOR REVIEW 1 23.09.24 50% ISSUE FOR REVIEW Reason for Issue


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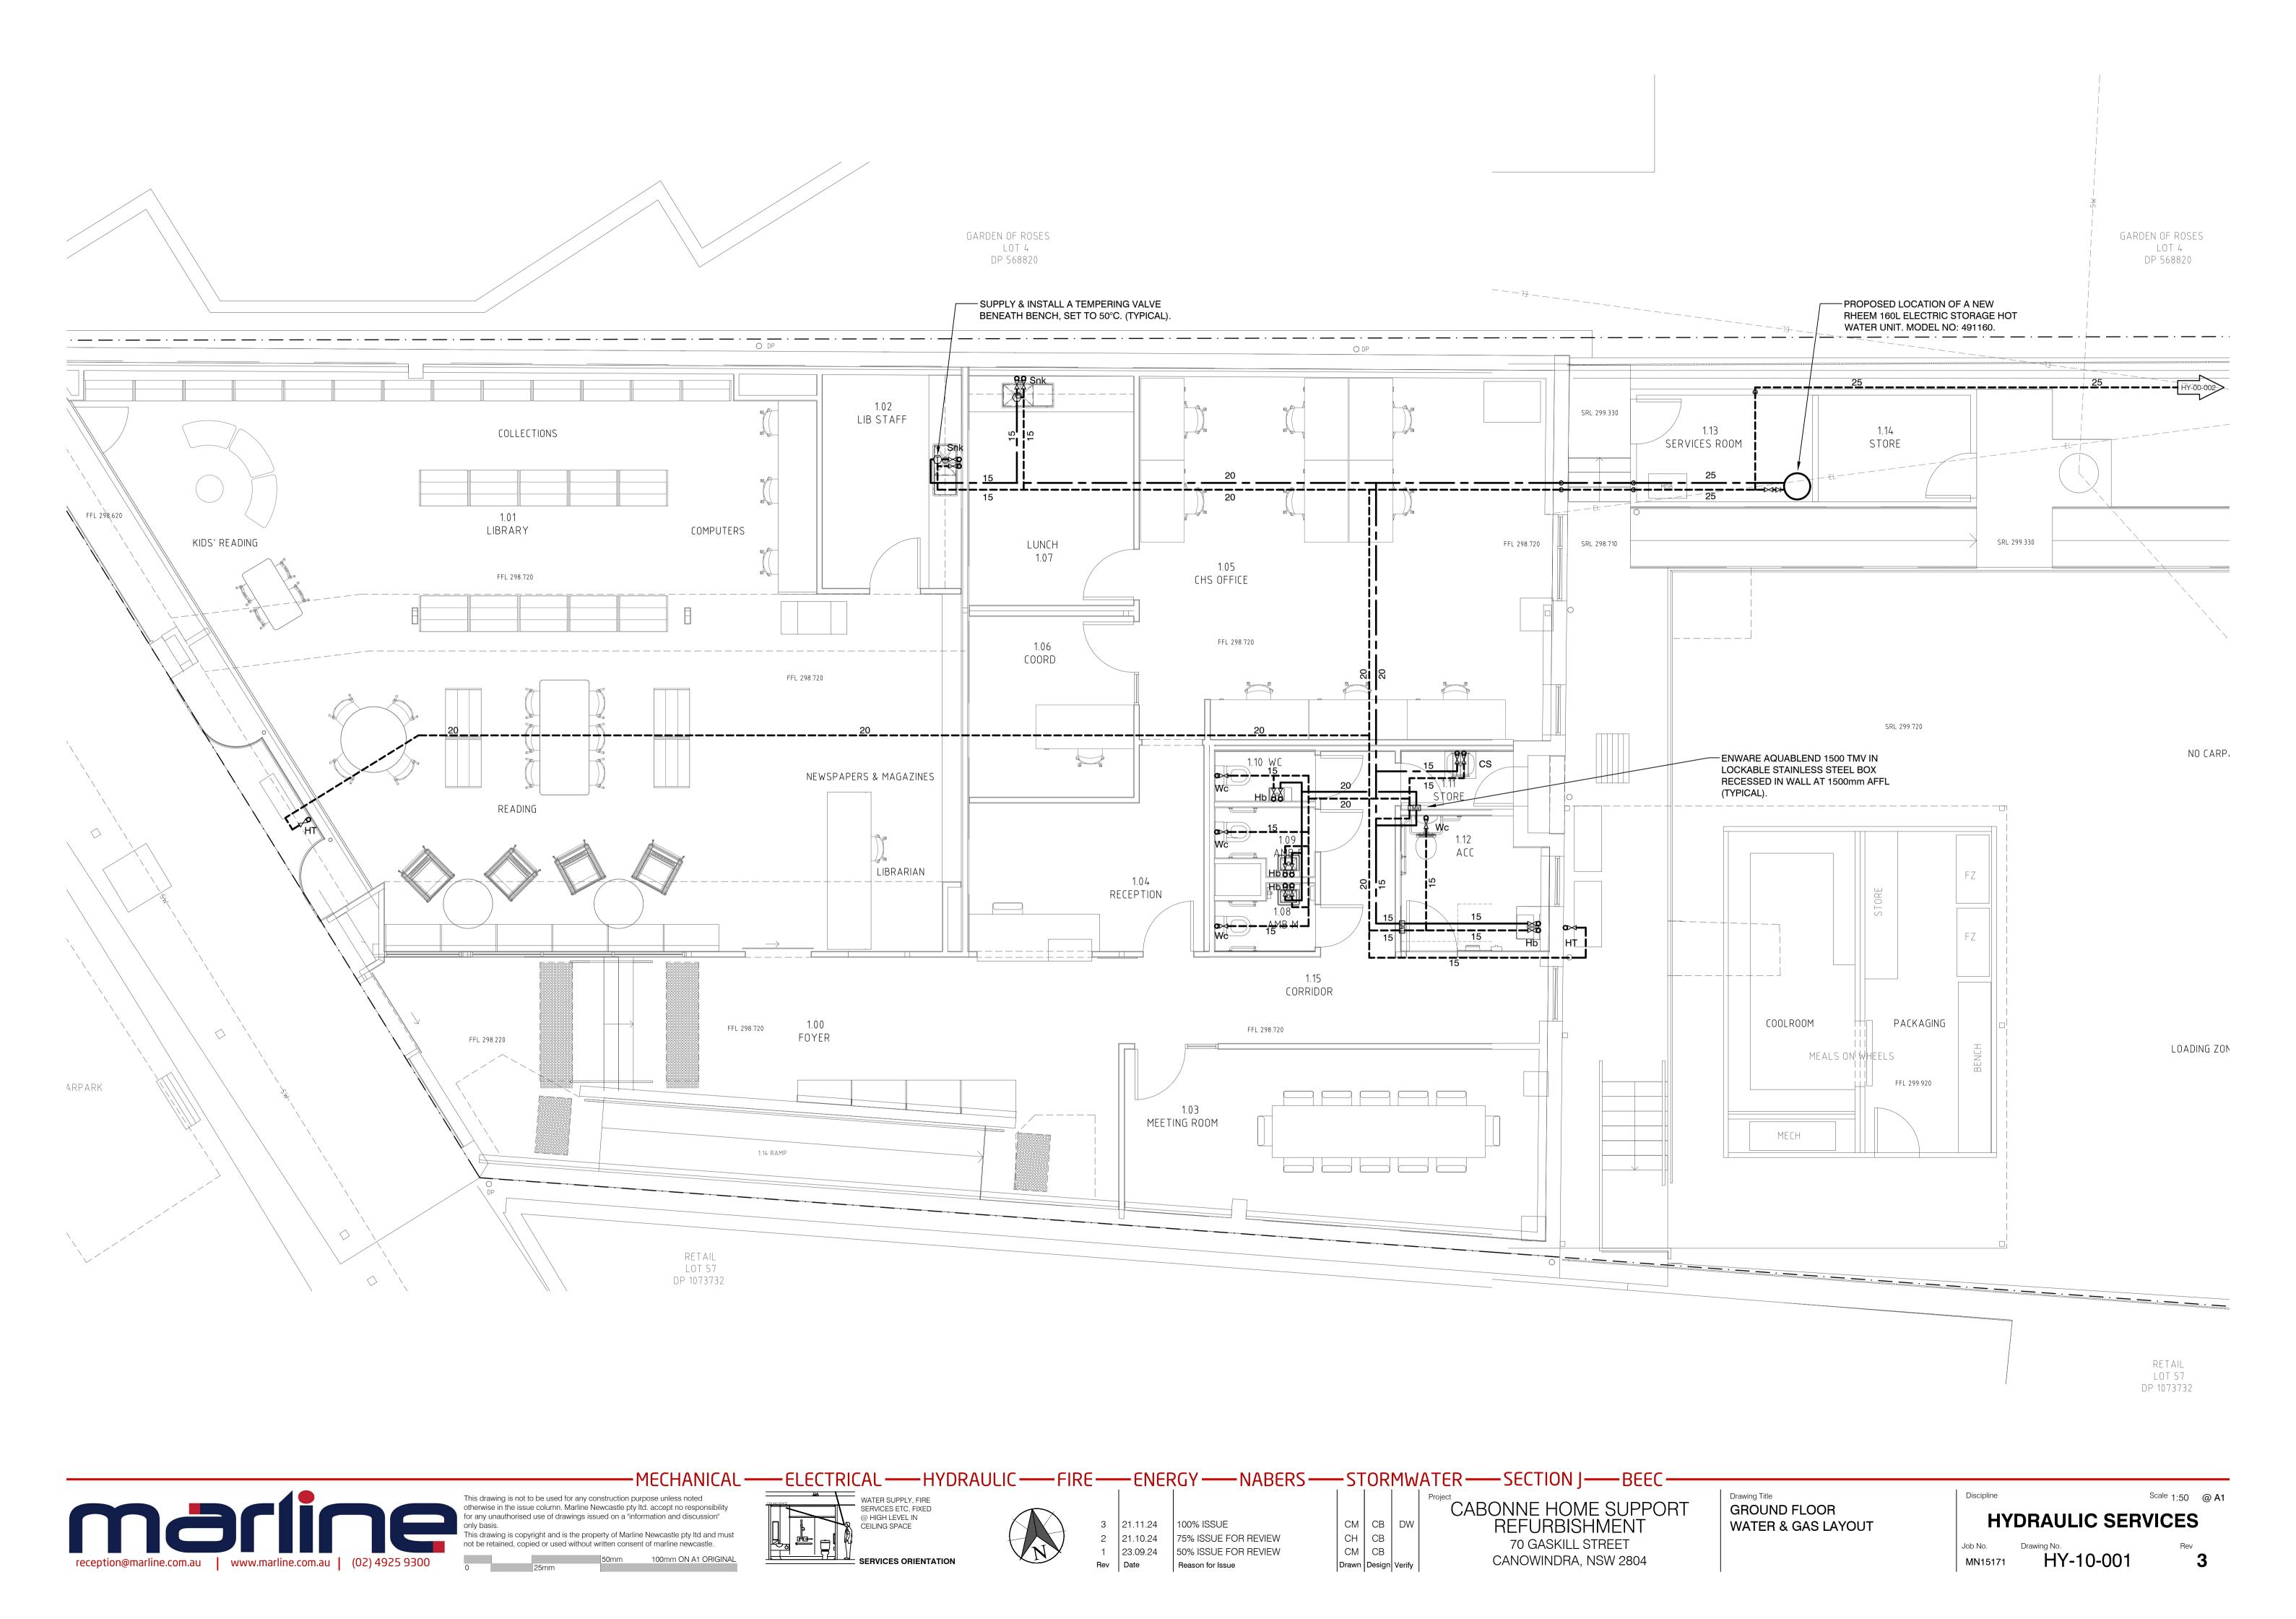
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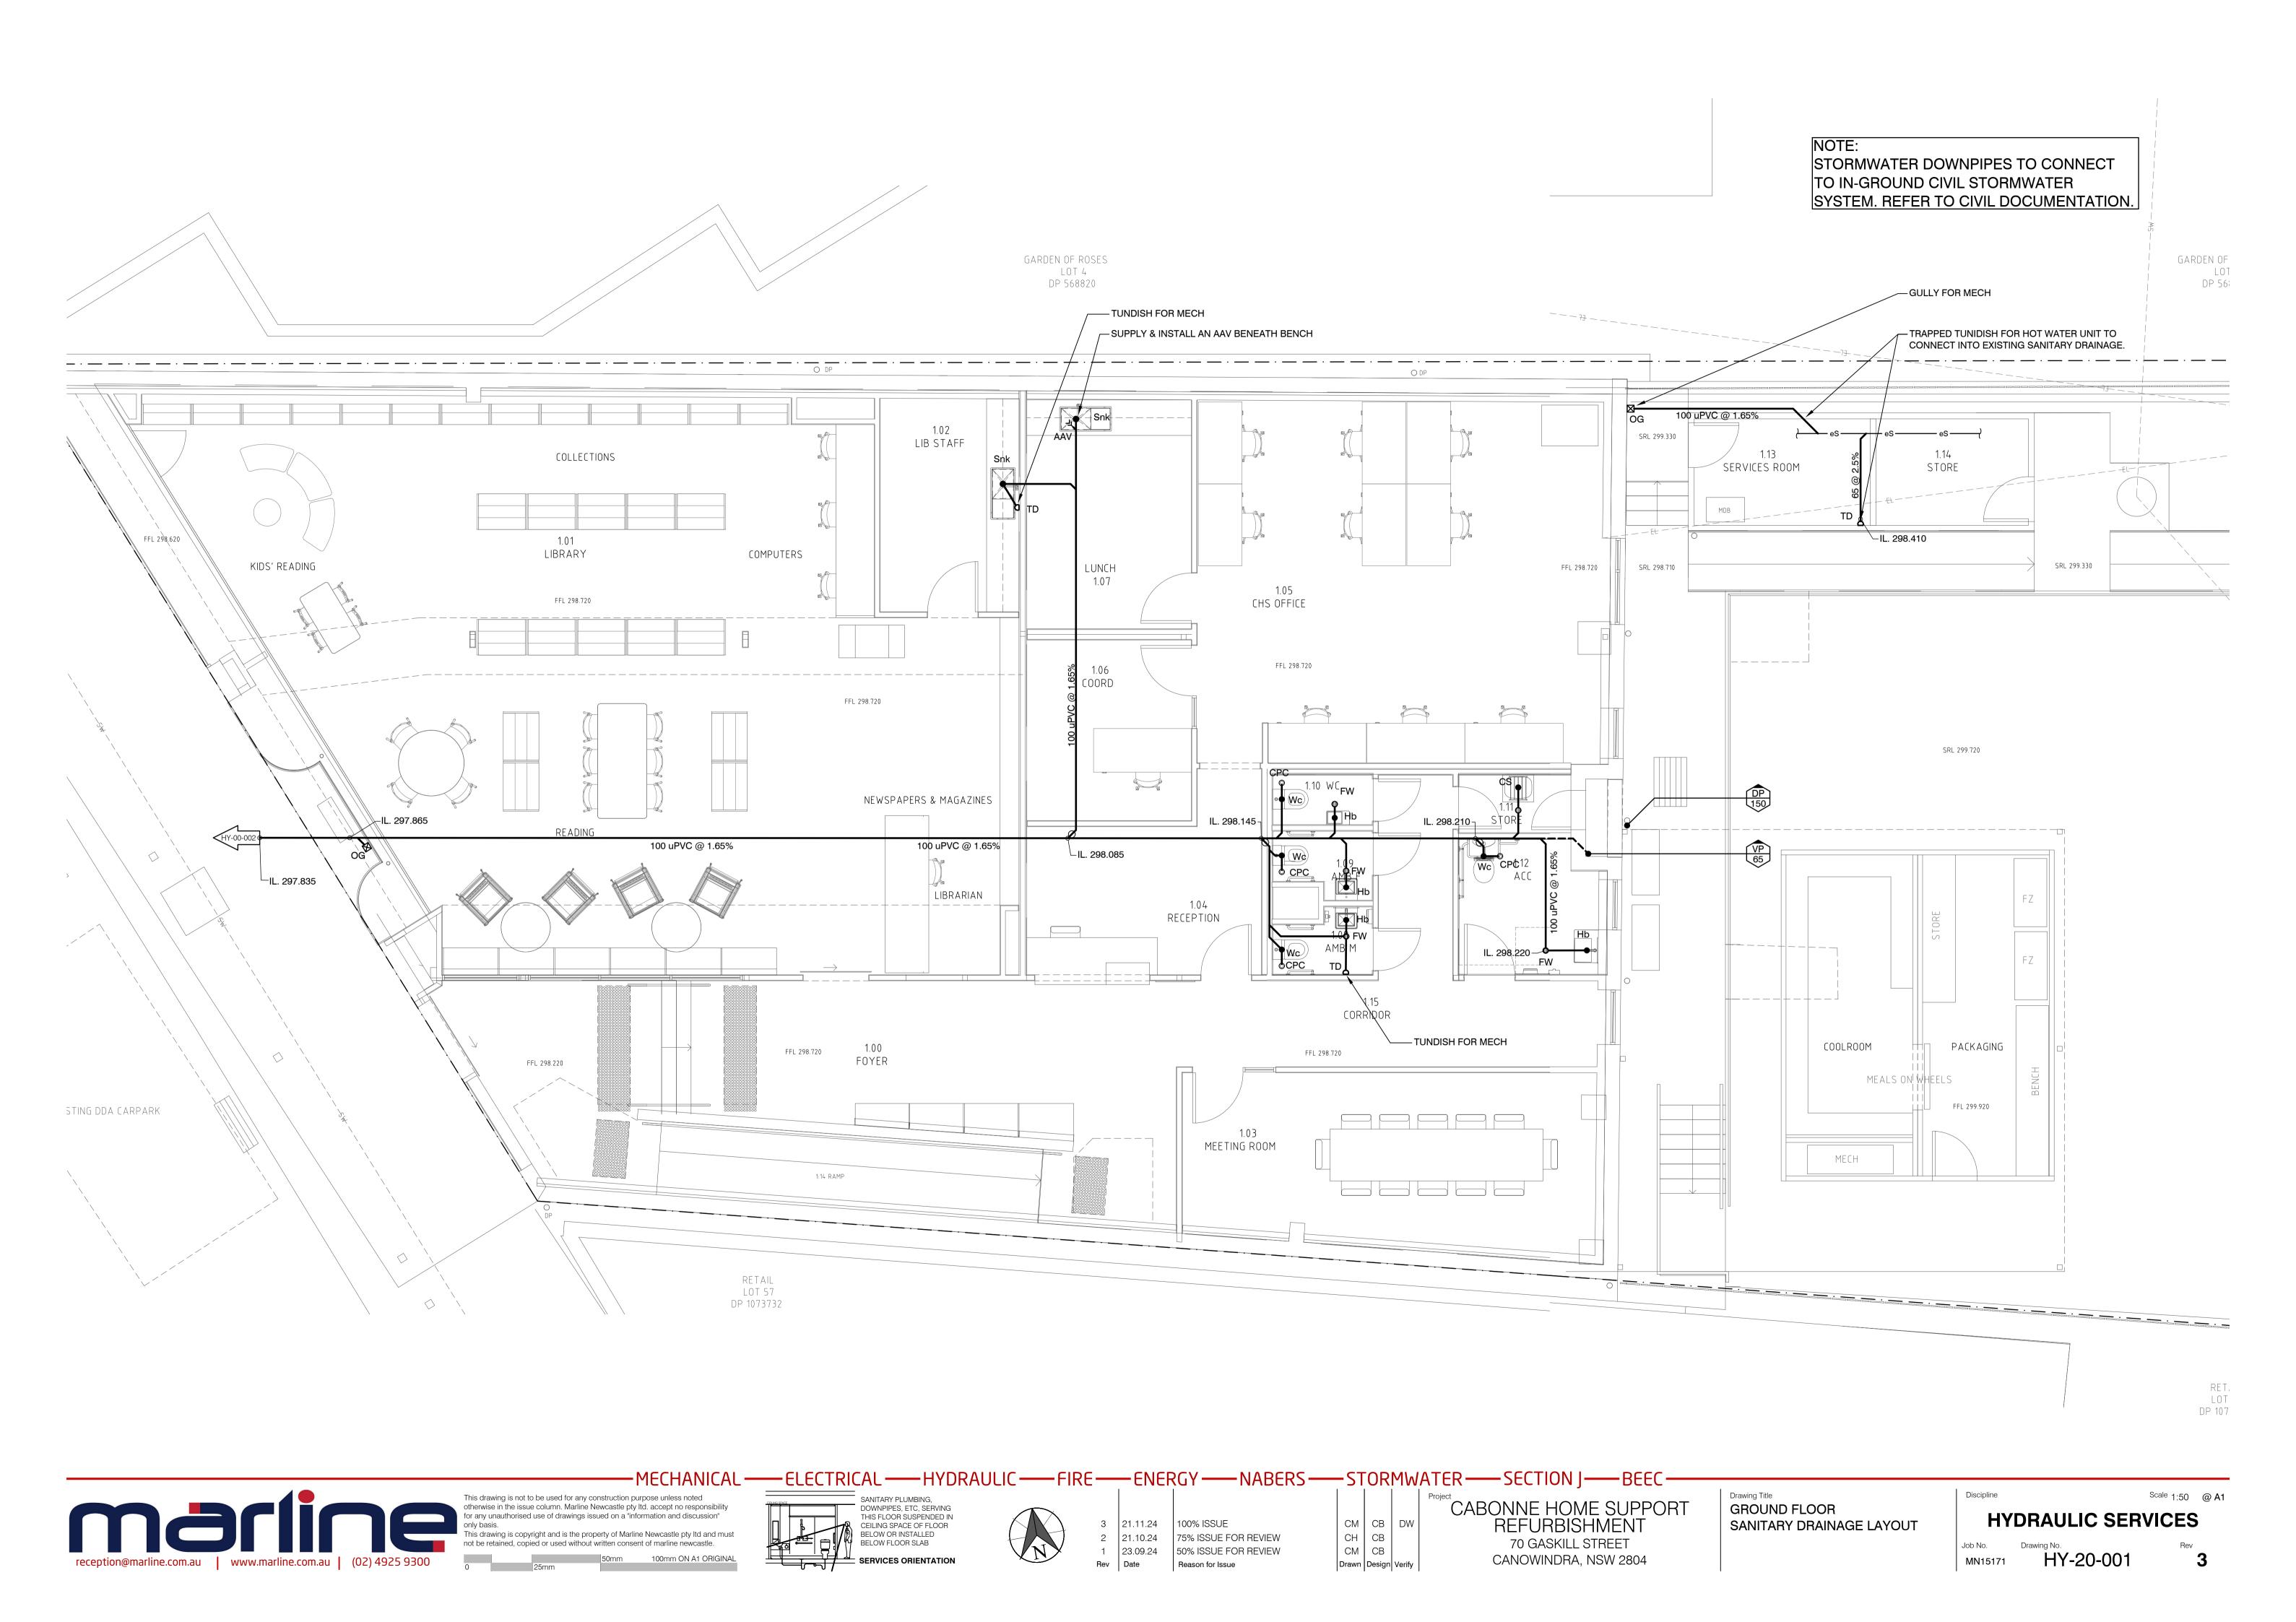
CABONNE HOME SUPPORT REFURBISHMENT 70 GASKILL STREET CANOWINDRA, NSW 2804


LEGEND & NOTES

Discipline Scale N.T.S @ A1 **HYDRAULIC SERVICES** HY-00-001





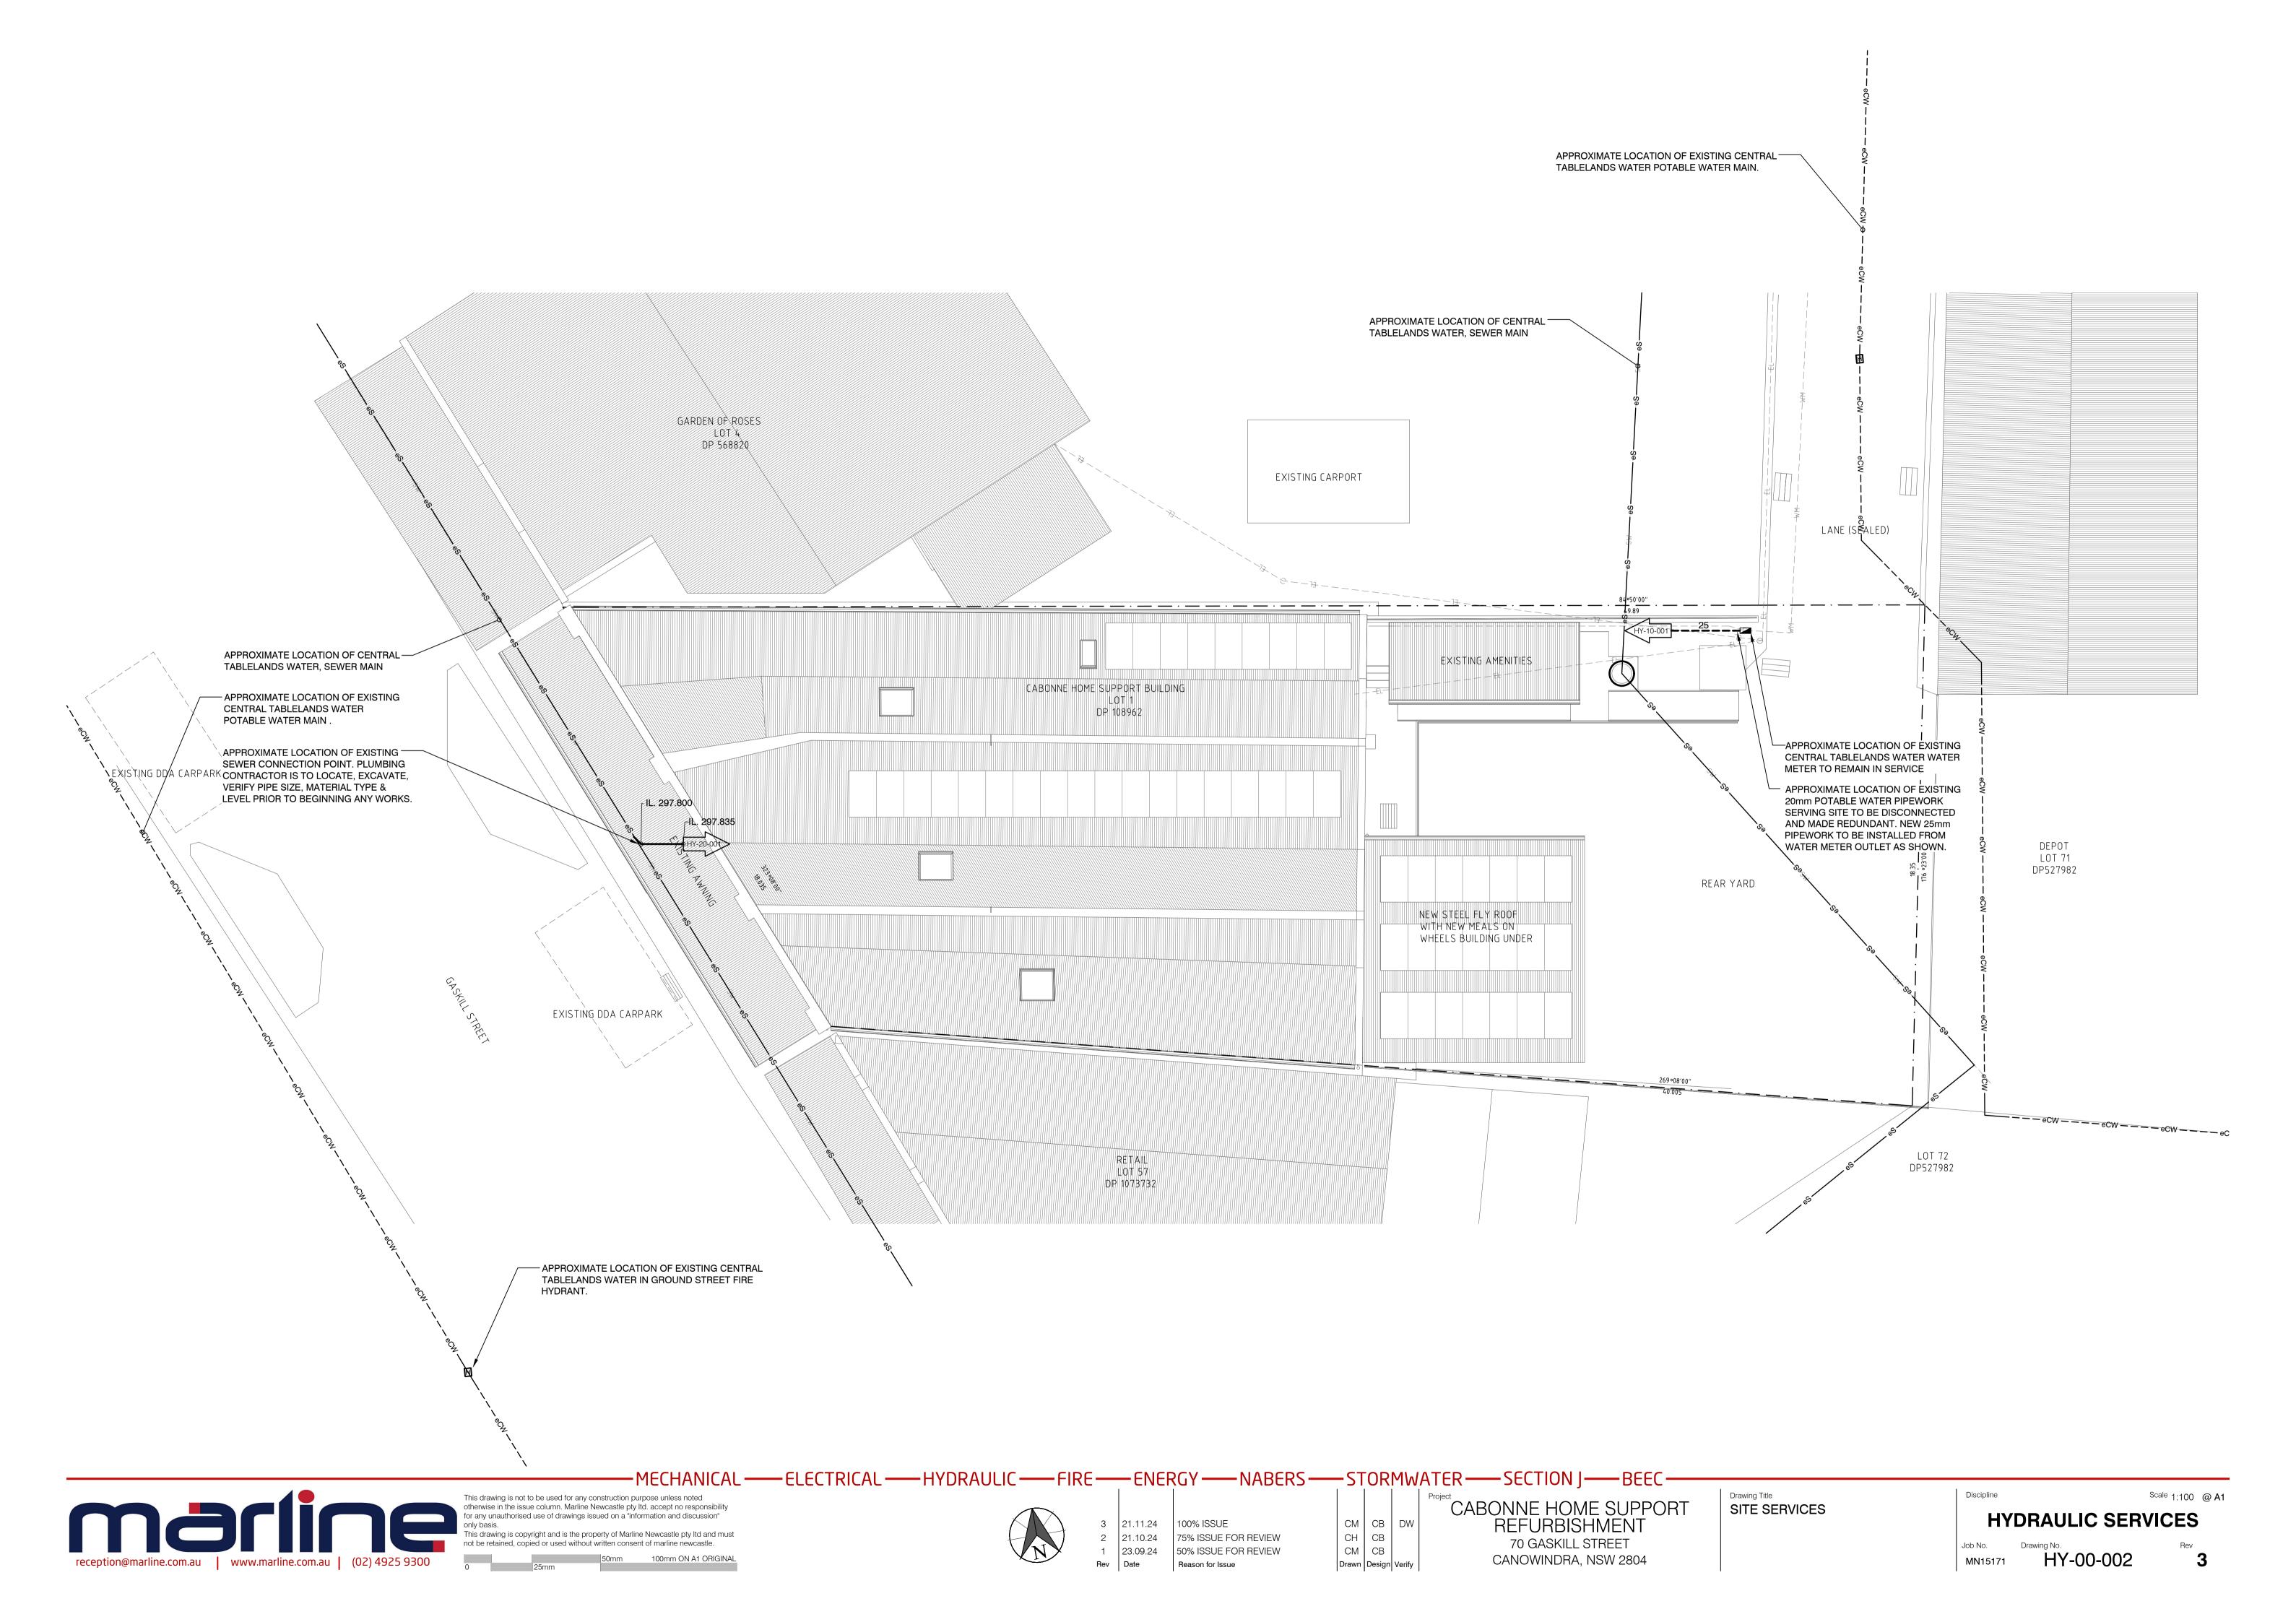

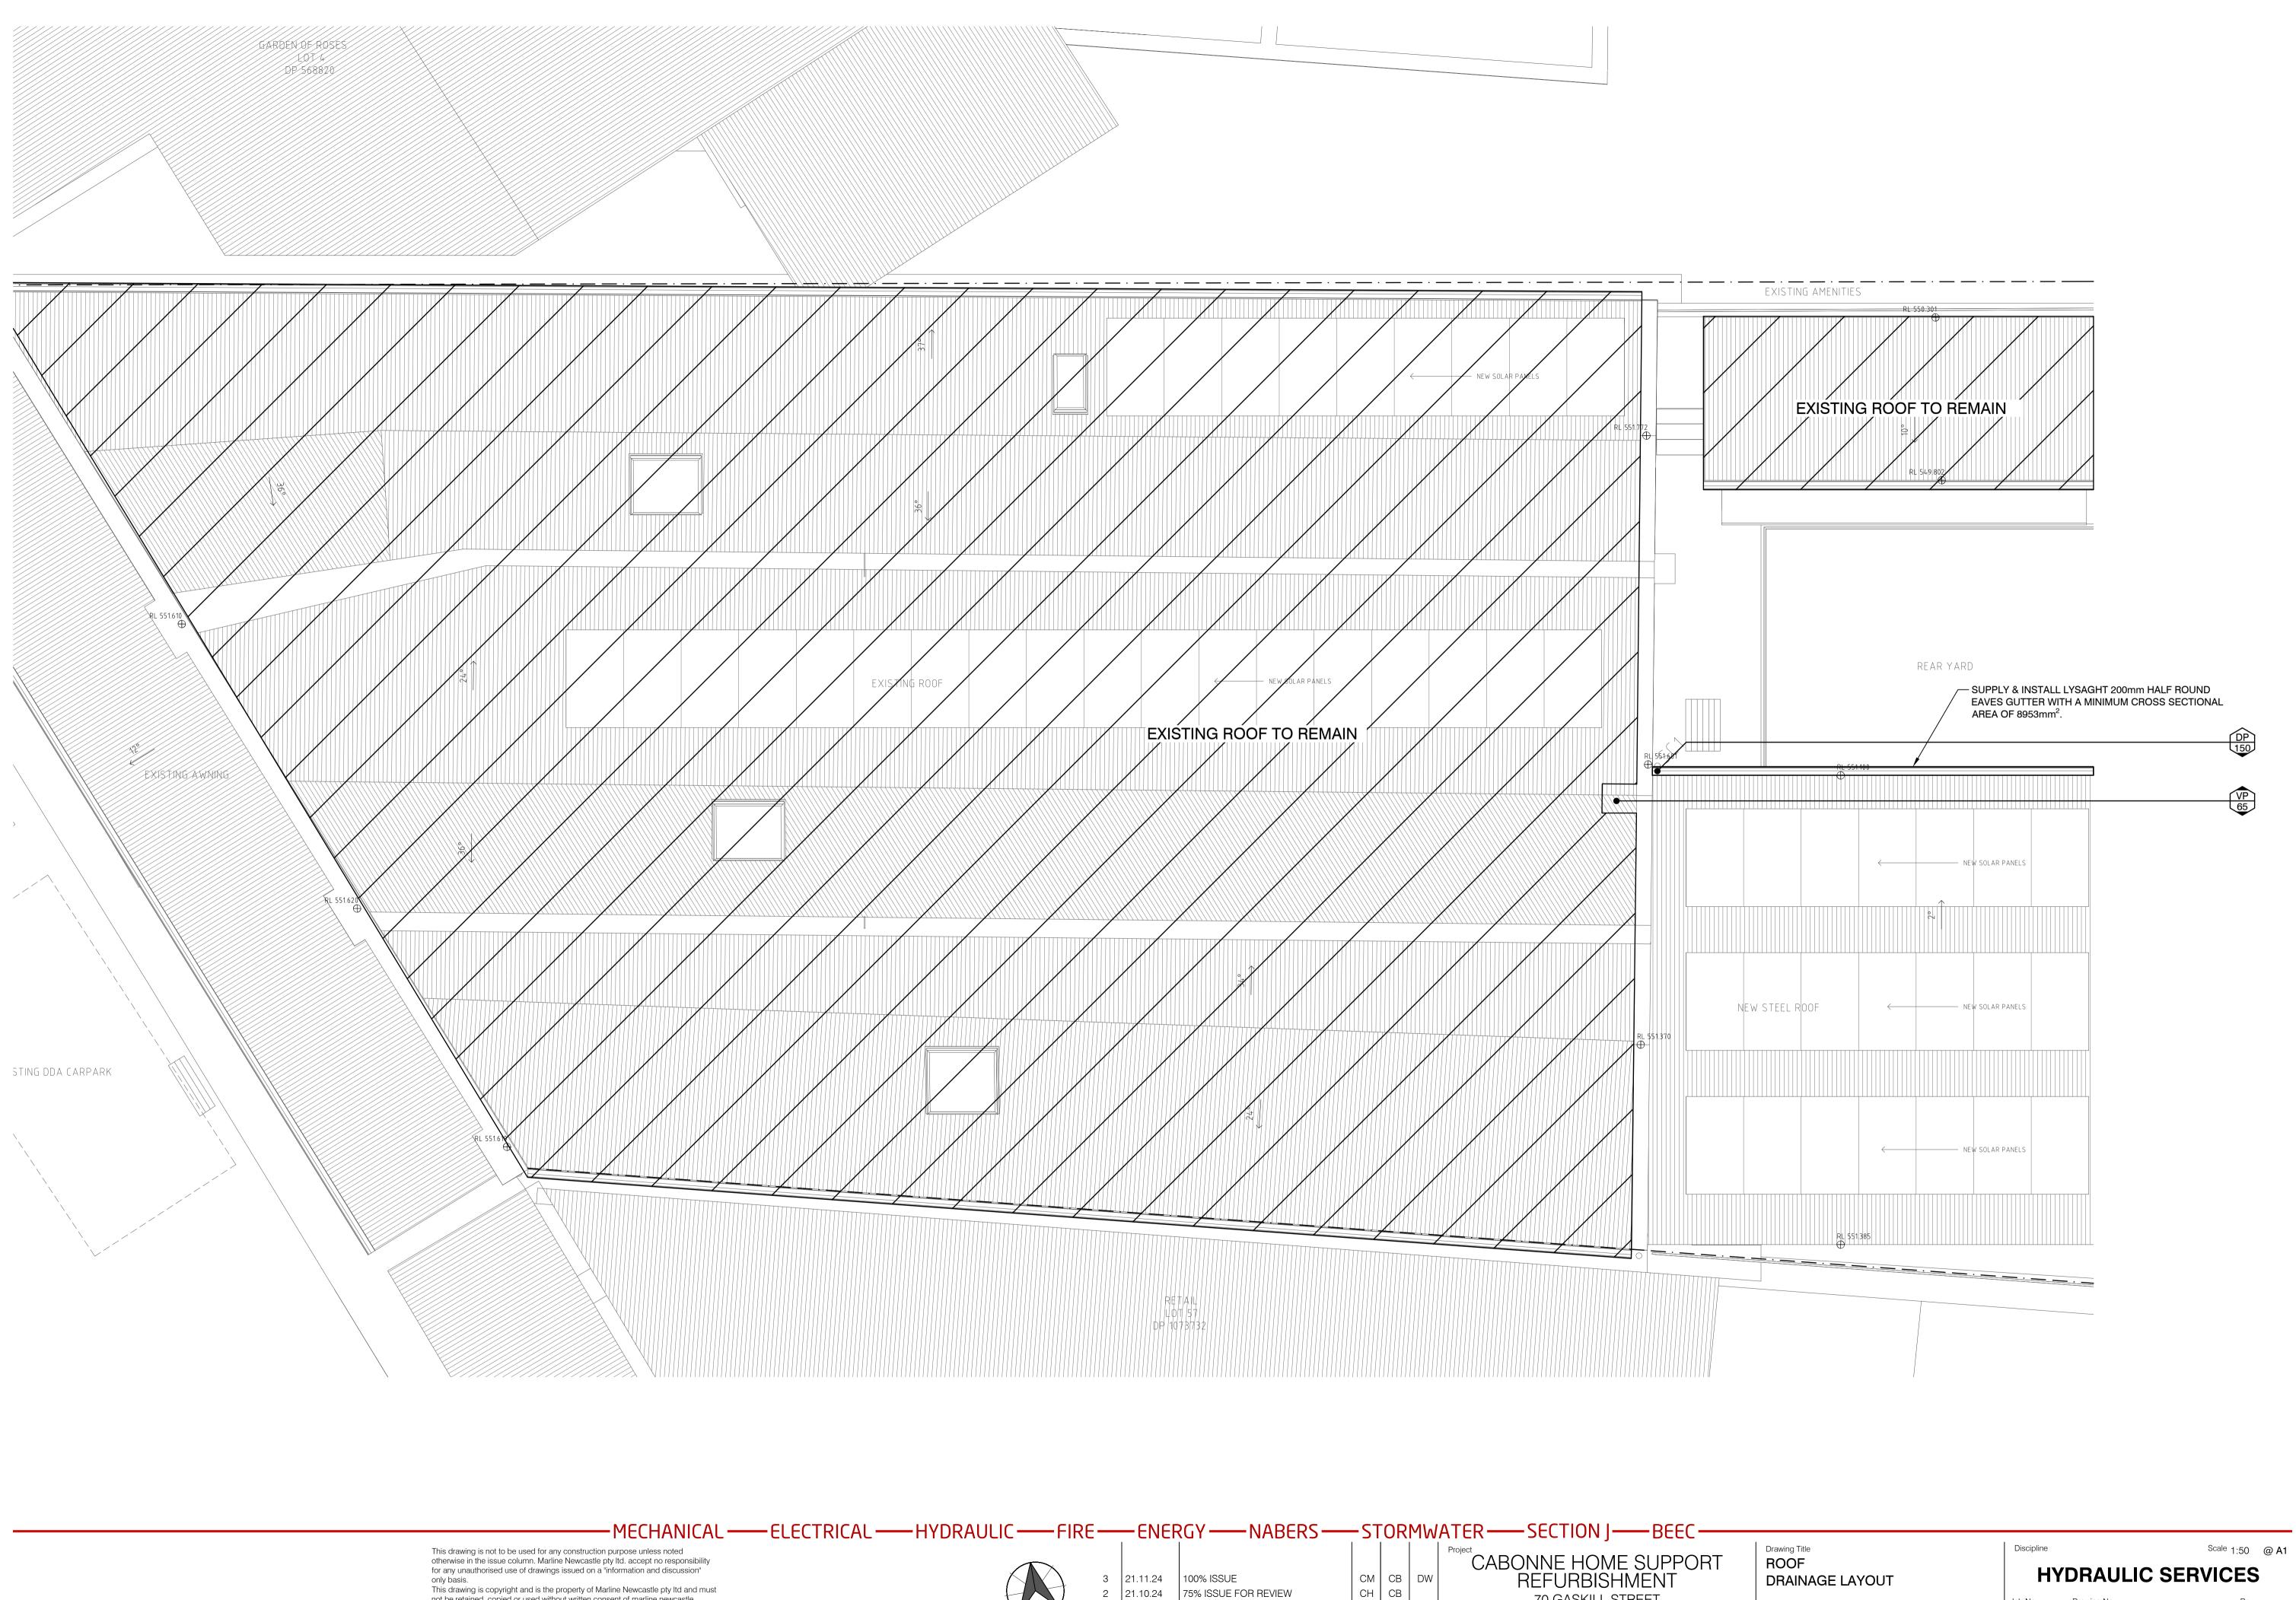


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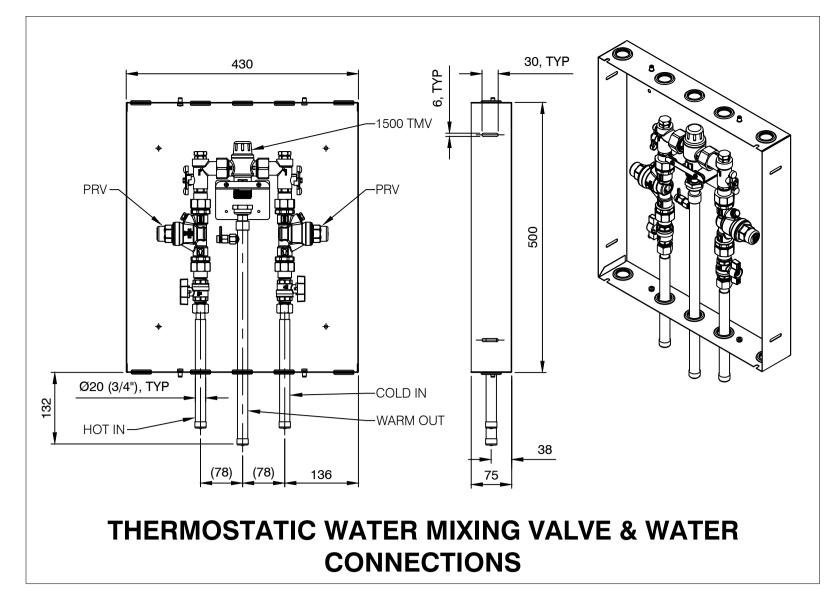
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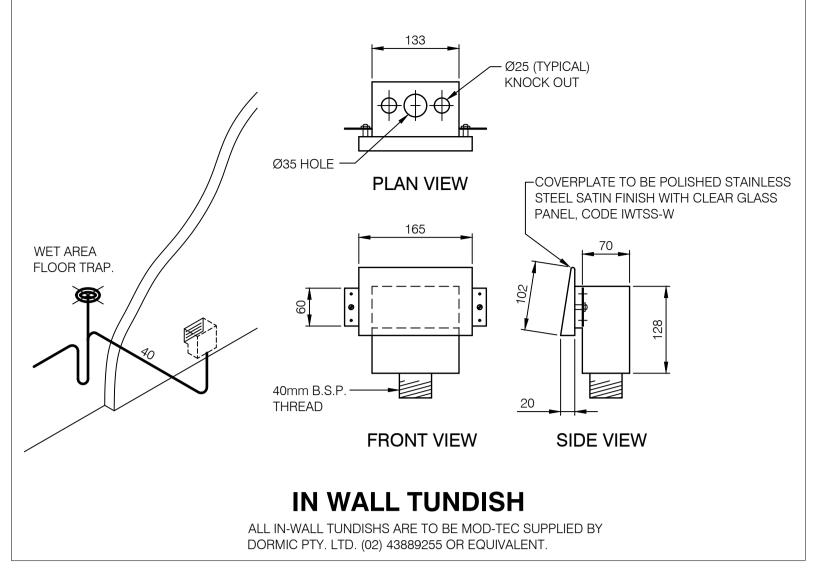
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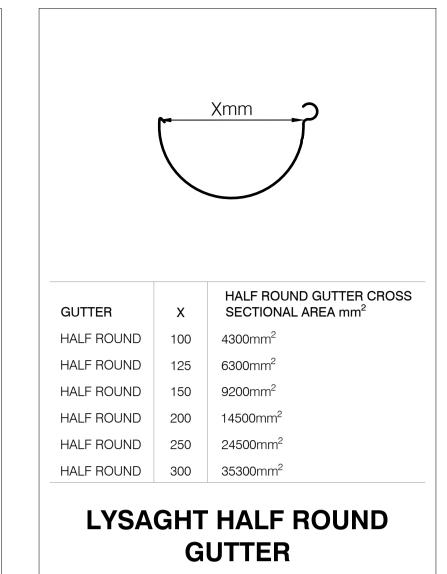
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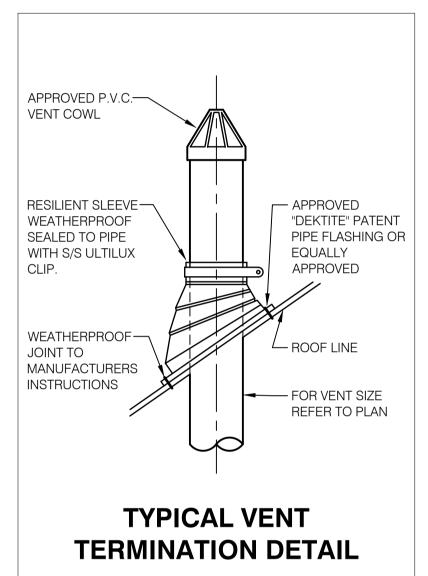



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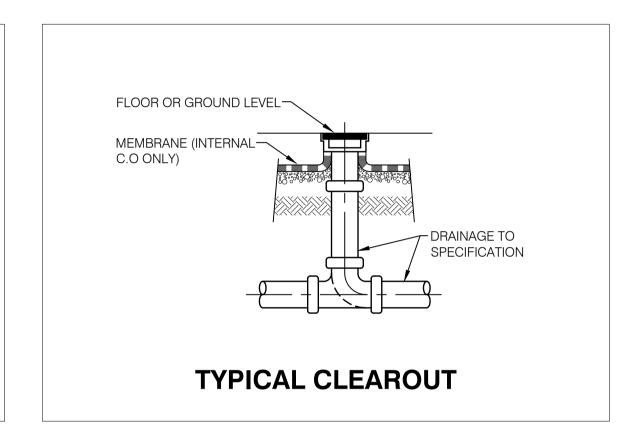






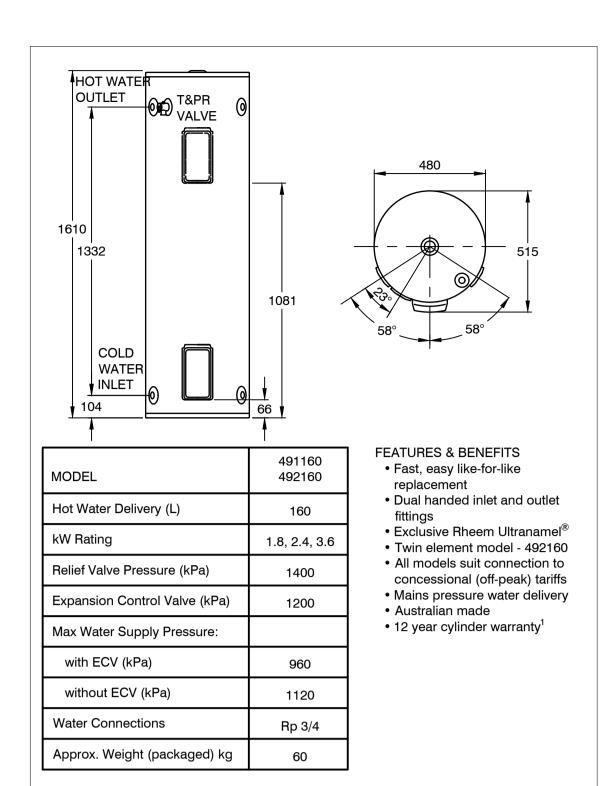



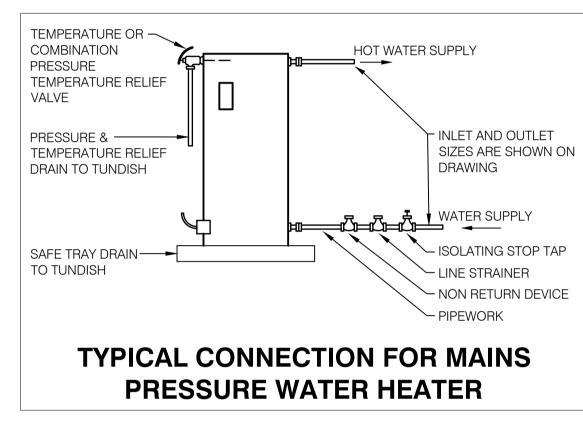



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Drawing Title

DETAILS

Discipline

Scale N.T.S @ A1

HYDRAULIC SERVICES

Job No. Drawing No. Rev

MN15171 HY-30-001 3